LEGAL DESCRIPTION

LOTS 15, 16, 17, 18 AND THE SOUTHERLY 5 FEET OF LOT 19, BLOCK 6, EAST SEATTLE, ACCORDING TO THE PLAT THEREOF RECORDED IN VOLUME 3 OF PLATS, PAGES 22 AND 23, RECORDS OF KING COUNTY, WASHINGTON; EXCEPT THAT PORTION THEREOF LYING WITHIN MERCER ISLAND ROAD (67TH AVENUE SE)

SITUATE IN THE CITY OF MERCER ISLAND, COUNTY OF KING, STATE OF WASHINGTON.

BASIS OF BEARING

RECORD OF SURVEY BY TERRANE FOR JAYMARC HOMES, RECORDED ON JULY 26, 2021, IN VOLUME 451 OF SURVEYS, PAGE 259, UNDER RECORDING NO. 20210726900027, RECORDS

VERTICAL DATUM & CONTROL INTERVAL

ELEVATIONS SHOWN ON THIS DRAWING WERE DERIVED FROM INFORMATION PROVIDED BY THE CITY OF MERCER ISLAND.

THE MARK IS A MONUMENT IN CASE AT THE INTERSECTION OF 68TH AVENUE SE W AND SE 32ND STREET.

POINT ID NO. 47746;

ELEVATION: 112.571 FEET - NAVD 88

2.0' CONTOUR INTERVAL - THE EXPECTED VERTICAL ACCURACY IS EQUAL TO 1/2 THE CONTOUR INTERVAL OR PLUS / MINUS 1.0' FOR THIS PROJECT.

SURVEY NOTES

- 1. THIS SURVEY WAS COMPLETED WITHOUT BENEFIT OF A CURRENT TITLE REPORT. EASEMENTS AND OTHER ENCUMBRANCES MAY EXIST ON THIS PROPERTY THAT ARE
- 2. INSTRUMENTATION FOR THIS SURVEY WAS A 3-SECOND SPECTRAPRECISION FOCUS 35 TOTAL STATION. PROCEDURES USED IN THIS SURVEY MEET OR EXCEED STANDARDS SET BY WAC 332-130-090.
- 3. THE INFORMATION ON THIS MAP REPRESENTS THE RESULTS OF A SURVEY MADE IN AUGUST 2021 AND CAN ONLY BE CONSIDERED AS INDICATING THE GENERAL CONDITIONS EXISTING AT THAT TIME. 4. UTILITIES SHOWN ON THIS SURVEY ARE BASED UPON ABOVE GROUND
- OBSERVATIONS AND AS-BUILT PLANS WHERE AVAILABLE. ACTUAL LOCATIONS OF UNDERGROUND UTILITIES MAY VARY AND UTILITIES NOT SHOWN ON THIS SURVEY MAY EXIST ON THIS SITE.
- 5. ALL MONUMENTS WERE LOCATED DURING THIS SURVEY UNLESS OTHERWISE NOTED.

SITE DATA

HIGHEST ELEVATION OF LOT: LOWEST ELEVATION OF LOT: LOT SLOPE: 19.3% TOTAL SITE AREA: 12,500 SF ALLOWED LOT COVERAGE: PROPOSED LOT COVERAGE * 3.794 SF (33.7%) PROPOSED HARDSCAPE 201 SF (1.8%)

PROJECT IMPERVIOUS AREA: 3,995 SF (35.5%) * LOT COVERAGE INCLUDES THE COMBINATION OF BUILDINGS, INCLUDING EAVES AND ROOF OVERHANGS, AND VEHICULAR DRIVING SURFACES AS DEFINED PER MIMC 19.16.010

OWNER / ARCHITECT

WILLIAM E. BUCHAN INC. 2630 116 AVE NE #100 BELLEVUE, WA 98004 (425) 831–5503 CONTACT: DAVID STAVE

ENGINEER

THE BLUELINE GROUP 25 CENTRAL WAY, SUITE 400 KIRKLAND, WA 98033 (425) 250-7262 CONTACT: YANNICK METS, PE

GEOTECH ENGINEER

TERRA ASSOCIATES, INC 12220 113TH AVE NE. SUITE 130 KIRKLAND, WA 98034 (425) 821-7777 CONTACT: CAROLYN S. DECKER, PE

3036 67TH AVE SE MERCER ISLAND SITE PLAN

CONCRETE DRIVEWAY

PROPOSED TRENCH DRAIN


PROPOSED SINGLE


FAMILY RESIDENCE

MFE 110.56

GFE 98.75

PLANTER .

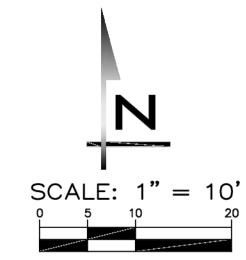

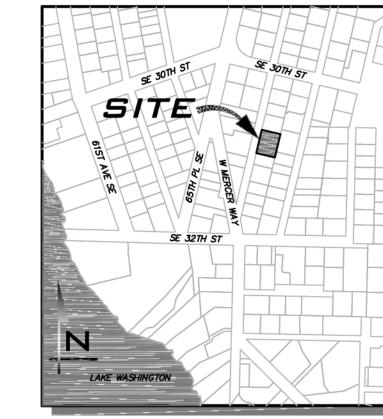

VICINITY MAP NOT TO SCALE

LEGEND PROPOSED FEATURES

----BOUNDARY - RIGHT-OF-WAY ASPHALT PAVEMENT - LOT LINE - SIDEWALK CONCRETE - CENTER LINE ---- SAWCUT LLLLLLLLL BUILDING FOOTPRINT

— — — — — BUILDING OVERHANG - BUILDING ROOFLINE — — — — — — BUILDING SETBACK (BSBL) -190----- 10' PROPOSED CONTOURS -192---- 2' PROPOSED CONTOURS

PROPOSED STORM DRAINAGE ☑ TYPE I CB — STANDARD GRATE ---- ROOF & FOOTING DRAIN STORM CLEANOUT

→ ··· → ··· SWALE OR DITCH → SURFACE FLOW YARD DRAIN EXISTING FEATURES - ADJACENT PLAT/PARCEL LINE | P | POWER VAULT - ADJACENT RIGHT-OF-WAY **∕**S POWER METER ----- -- CENTERLINE ----- ----- EASEMENT — — — — — SURFACE FEATURES /_/_/_/_/__BUILDING FOOTPRINT — — —190— — — 10' CONTOURS ----192---- 2' CONTOURS

 \Box MAIL BOX EXISTING CONIFEROUS TREE — — — SD— *Storm Drain Pipe* — — — SS— **SEWER MAIN** EXISTING DECIDUOUS TREE — — — W — WATER MAIN → DRIP LINE — — — OHP— **AERIAL POWER LINE** CONIFEROUS TREE — — — G— GAS MAIN TO BE SAVED — — — □ — BOARD FENCE

RETAINING WALL COOCCOOCC ROCKERY ☐ CATCH BASIN, TYPE I CATCH BASIN, TYPE II SD PIPE FLOW SEWER MANHOLE SS PIPE FLOW A FIRE HYDRANT

← GUY ANCHOR

TO BE REMOVED EXISTING DECIDUO
TO BE REMOVED EXISTING DECIDUOUS TREE **⊞** WATER METER ASPHALT ⋈ GATE VALVE -O- POWER POLE

DECIDUOUS TREE

EXISTING CONIFEROUS TREE

INTERIM CATCH BASIN

TO BE SAVED


CONCRETE

—∳ STREET LIGHT GRAVEL TESC FEATURES FILTER FENCE ----- CONSTRUCTION FENCE ✓ PIPE FLOW CLEARED AREA INTERIM CATCH BASIN PROTECTION (INSERT) LIMITS OF CLEARING

EXISTING UTILITY NOTE

EXISTING UTILITIES ARE SHOWN IN THE APPROXIMATE LOCATION. THERE IS NO GUARANTEE THAT ALL UTILITY LINES ARE SHOWN, OR THAT THE LOCATION, SIZE AND MATERIAL IS ACCURATE. THE CONTRACTOR SHALL UNCOVER ALL INDICATED PIPING WHERE CROSSING, INTERFERENCES, OR CONNECTIONS OCCUR PRIOR TO TRENCHING OR EXCAVATION FOR ANY PIPE OR STRUCTURES, TO DETERMINE ACTUAL LOCATIONS, SIZE AND MATERIAL. THE CONTRACTOR SHALL MAKE THE APPROPRIATE PROVISION FOR PROTECTION OF SAID FACILITIES. THE CONTRACTOR SHALL NOTIFY <u>ONE CALL</u> AT 8-1-1 (WASHINGTON811.COM) AND ARRANGE FOR FIELD LOCATION OF EXISTING FACILITIES BEFORE CONSTRUCTION.

BLUELINE KIRKLAND, WA 98033 P: 425.216.4051 F: 425.216.4052 WWW.THEBLUELINEGROUP.COM SCALE: AS NOTED PROJECT MANAGER: YANNICK METS, PE PROJECT ENGINEER: ALI RAMEZANI, PE DESIGNER: CHRISTOPHER WISCOMB ISSUE DATE: 6/14/2022

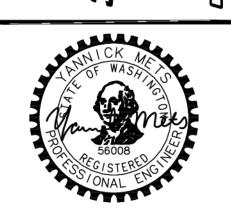

6/16/22 JOB NUMBER:

22-042 SHEET NAME: CV-01

l OF

SHEET INDEX 1 CV-01 COVER SHEET

5 DT-01 SITE DETAILS

2 TP-01 TESC, DRAINAGE & TREE RETENTION PLAN

HEDGE

3 TP-02 TESC NOTES & DETAILS 4 SP-01 SITE PLAN

OFFSET 6.00' W


₽ FIRE HYDRAN


BUILDING CALCULATIONS SEE ARCHITECTURAL SITE PLAN FOR TREE RETENTION, BUILDING HEIGHTS AND

<u>SET REBAR & CAP (38964)</u>

FAR CALCULATIONS.

XZ S ii © 2022 BLUELINE

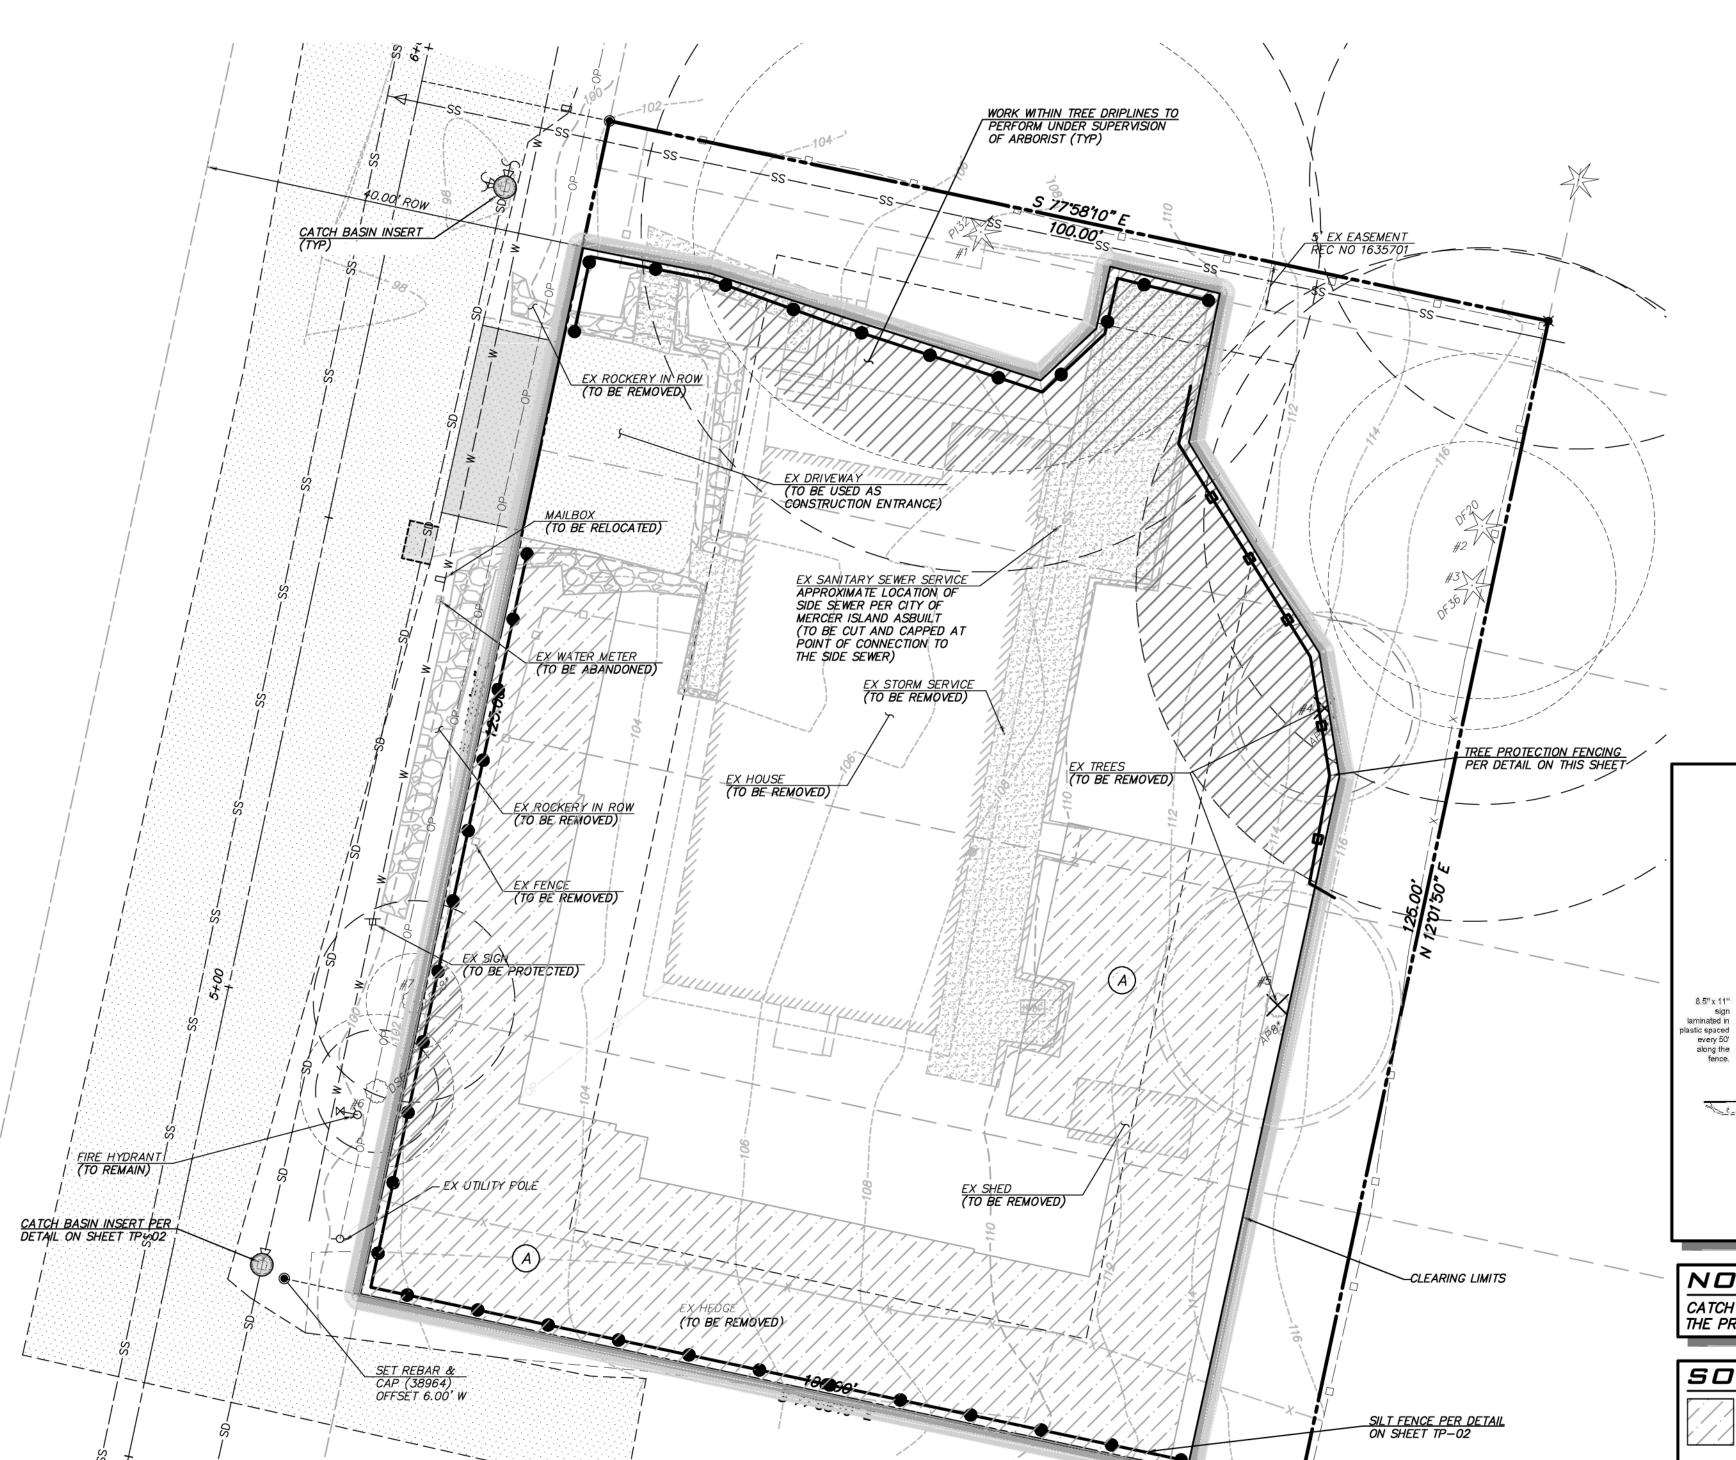

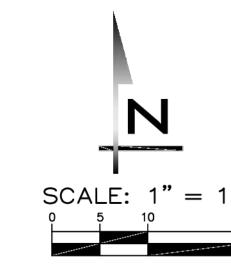

1. No pruning shall be performed unless under the

2. No equipment shall be stored or operated inside the protective fencing including during fence

No storage of materials shall occur inside the protective fencing.
 A. Refer to Site/Utility Plan for any modifications to the Tree Protection Area.
 Unauthorized activities in tree protection area.

may require evaluation by private arborist to identify impacts and mitigation required.

6. Exposed Roots: For roots >1' damaged during construction, make a clean straight cut to remove damaged portion and inform city arborist.

fence: High density polyethylene fencing with 3.5" x 1.5"

openings; Color-orange. Steel posts

- 2" x 6' steel posts

layer of mulch.

direction of an arborist.

installation and removal.



25 CENTRAL WAY, SUITE 400, KIRKLAND, WA 98033 P: 425.216.4051 F: 425.216.4052 WWW.THEBLUELINEGROUP.COM

SCALE: AS NOTED

PROJECT MANAGER:

YANNICK METS, PE PROJECT ENGINEER:

ALI RAMEZANI, PE

DESIGNER: CHRISTOPHER WISCOMB

ISSUE DATE: 6/14/2022

TREE PROTECTION FENCING

NOTE

CATCH BASIN INLET PROTECTION TO BE INSTALLED UP TO 250' DOWNSTREAM OF THE PROJECT SITE.

SOIL AMENDMENT LEGEND

Crown drip line or other limit of Tree Protection area. See Site/Utility Plan for fence alignment.

A NEW TURF AREA REQUIRING AMENDMENT (3,277 SF)

POST-CONSTRUCTION SOIL MANAGEMENT NOTES

AMEND SOILS WITH COMPOST PER PRE-APPROVED AMENDMENT METHOD SCARIFY EXISTING SOILS TO DEPTH OF 8 INCHES

REFER TO CITY OF MERCER ISLAND SECTION D: POST—CONSTRUCTION SOIL MANAGEMENT FORM UNDER SEPARATE COVER FOR CALCULATED AMENDMENT


NOTE

QUANTITIES.

EXISTING WATER METER TO BE ABANDONED.

EXISTING UTILITY NOTE

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6/16/22 JOB NUMBER: 22-042

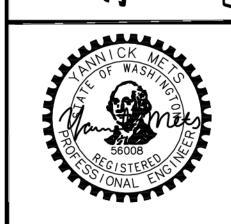SHEET NAME: TP-01

sнт <u>**2**</u> оғ <u>**5**</u>

A. CONDUCT PRE—CONSTRUCTION MEETING. B. FLAG OR FENCE CLEARING LIMITS.

C. POST SIGN WITH NAME AND PHONE NUMBER OF TESC SUPERVISOR.

D. INSTALL CATCH BASIN PROTECTION IF REQUIRED.

E. GRADE AND INSTALL CONSTRUCTION ENTRANCE(S).
F. INSTALL PERIMETER PROTECTION (SILT FENCE, BRUSH BARRIER, ETC.).

G. CONSTRUCT SEDIMENT PONDS AND TRAPS.

H. GRADE AND STABILIZE CONSTRUCTION ROADS.

I. CONSTRUCT SURFACE WATER CONTROLS (INTERCEPTOR DIKES, PIPE SLOPE DRAINS, ETC.)

SIMULTANEOUSLY WITH CLEARING AND GRADING FOR PROJECT DEVELOPMENT.

J. MAINTAIN EROSION CONTROL MEASURE IN ACCORDANCE WITH CITY OF MERCER ISLAND
STANDARDS AND MANUFACTURER'S RECOMMENDATIONS.

K. RELOCATE EROSION CONTROL MEASURES OR INSTALL NEW MEASURES SO THAT AS SITE CONDITIONS CHANGE, THE EROSION AND SEDIMENT CONTROL IS ALWAYS IN ACCORDANCE WITH THE CITY TESC MINIMUM REQUIREMENTS.

L. COVER ALL AREAS WITHIN THE SPECIFIED TIME FRAME WITH STRAW, WOOD FIBER MULCH, COMPOST, PLASTIC SHEETING, CRUSHED ROCK OR EQUIVALENT.

M. STABILIZE ALL AREAS THAT REACH FINAL GRADE WITHIN 7 DAYS. N. SEED OR SOD ANY AREAS TO REMAIN UNWORKED FOR MORE THAN 30 DAYS.

O. UPON COMPLETION OF THE PROJECT, ALL DISTURBED AREAS MUST BE STABILIZED AND BEST MANAGEMENT PRACTICES REMOVED IF APPROPRIATE.

APPROVAL OF THIS EROSION/SEDIMENTATION CONTROL (ESC) PLAN DOES NOT CONSTITUTE AN APPROVAL OF PERMANENT ROAD OR DRAINAGE DESIGN (E.G., SIZE AND LOCATION OF

ROADS, PIPES, RESTRICTORS, CHANNELS, RETENTION FACILITIES, UTILITIES, ETC.).

3. THE IMPLEMENTATION OF THIS ESC PLAN AND THE CONSTRUCTION, MAINTENANCE, REPLACEMENT, AND UPGRADING OF THESE ESC FACILITIES IS THE RESPONSIBILITY OF THE PERMITTEE/CONTRACTOR UNTIL ALL CONSTRUCTION IS APPROVED.

4. THE BOUNDARIES OF THE CLEARING LIMITS SHOWN ON THIS PLAN SHALL BE SET BY SURVEY AND CLEARLY FLAGGED IN THE FIELD BY A CLEARING CONTROL FENCE PRIOR TO CONSTRUCTION. DURING THE CONSTRUCTION PERIOD, NO DISTURBANCE OR REMOVAL OF ANY GROUND COVER BEYOND THE FLAGGED CLEARING LIMITS SHALL BE PERMITTED. THE FLAGGING SHALL BE MAINTAINED BY THE PERMITTEE/CONTRACTOR FOR THE DURATION OF CONSTRUCTION.

5. THE TESC FACILITIES SHOWN ON THIS PLAN MUST BE CONSTRUCTED PRIOR TO OR IN CONJUNCTION WITH ALL CLEARING AND GRADING ACTIVITIES IN SUCH A MANNER AS TO ENSURE THAT SEDIMENT—LADEN WATER DOES NOT ENTER THE DRAINAGE SYSTEM OR VIOLATE APPLICABLE WATER STANDARDS. WHEREVER POSSIBLE, MAINTAIN NATURAL VEGETATION FOR SILT CONTROL.

6. THE ESC FACILITIES SHOWN ON THIS PLAN ARE THE MINIMUM REQUIREMENTS FOR ANTICIPATED SITE CONDITIONS. DURING THE CONSTRUCTION PERIOD, THESE ESC FACILITIES SHALL BE UPGRADED (E.G., ADDITIONAL SUMPS, RELOCATION OF DITCHES AND SILT FENCES, ETC.) AS NEEDED FOR UNEXPECTED STORM EVENTS. ADDITIONALLY, MORE TESC FACILITIES MAY BE REQUIRED TO ENSURE COMPLETE SILTATION CONTROL. THEREFORE, DURING THE COURSE OF CONSTRUCTION IT SHALL BE THE OBLIGATION AND RESPONSIBILITY OF THE CONTRACTOR TO ADDRESS ANY NEW CONDITIONS THAT MAY BE CREATED BY HIS ACTIVITIES AND TO PROVIDE ADDITIONAL FACILITIES OVER AND ABOVE THE MINIMUM REQUIREMENTS AS MAY BE NEEDED.

7. THE ESC FACILITIES SHALL BE INSPECTED BY THE PERMITTEE/CONTRACTOR DAILY DURING NON-RAINFALL PERIODS, EVERY HOUR (DAYLIGHT) DURING A RAINFALL EVENT, AND AT THE END OF EVERY RAINFALL, AND MAINTAINED AS NECESSARY TO ENSURE THEIR CONTINUED FUNCTIONING. IN ADDITION, TEMPORARY SILTATION PONDS AND ALL TEMPORARY SILTATION CONTROLS SHALL BE MAINTAINED IN A SATISFACTORY CONDITION UNTIL SUCH TIME THAT CLEARING AND/OR CONSTRUCTION IS COMPLETED, PERMANENT DRAINAGE FACILITIES ARE OPERATIONAL, AND THE POTENTIAL FOR EROSION HAS PASSED. WRITTEN RECORDS SHALL BE KEPT DOCUMENTING THE REVIEWS OF THE ESC FACILITIES.

8. THE ESC FACILITIES ON INACTIVE SITES SHALL BE INSPECTED AND MAINTAINED A MINIMUM OF ONCE A MONTH OR WITHIN 48 HOURS FOLLOWING A STORM EVENT.

9. ALL DENUDED SOILS MUST BE STABILIZED WITH AN APPROVED TESC METHOD (E.G. SEEDING, MULCHING, PLASTIC COVERING, CRUSHED ROCK) WITHIN THE FOLLOWING TIMELINES:

APRIL 1 TO OCTOBER 31 — SOILS MUST BE STABILIZED WITHIN 7 DAYS OF GRADING.

NOVEMBER 1 TO MARCH 31 — SOILS MUST BE STABILIZED WITHIN 2 DAYS OF GRADING.

10. AT NO TIME SHALL MORE THAN 1' OF SEDIMENT BE ALLOWED TO ACCUMULATE WITHIN A CATCH BASIN. ALL CATCH BASINS AND CONVEYANCE LINES SHALL BE CLEANED PRIOR TO PAVING. THE CLEANING OPERATION SHALL NOT FLUSH SEDIMENT—LADEN WATER INTO THE DOWNSTREAM SYSTEM.

11. STABILIZED CONSTRUCTION ENTRANCES SHALL BE INSTALLED AT THE BEGINNING OF CONSTRUCTION AND MAINTAINED FOR THE DURATION OF THE PROJECT. ADDITIONAL MEASURES, SUCH AS WASH PADS, MAY BE REQUIRED TO ENSURE THAT ALL PAVED AREAS ARE KEPT CLEAN FOR THE DURATION OF THE PROJECT.

12. ANY PERMANENT RETENTION/DETENTION FACILITY USED AS A TEMPORARY SETTLING BASIN SHALL BE MODIFIED WITH THE NECESSARY EROSION CONTROL MEASURES AND SHALL PROVIDE ADEQUATE STORAGE CAPACITY. IF THE PERMANENT FACILITY IS TO FUNCTION ULTIMATELY AS AN INFILTRATION OR DISPERSION SYSTEM, THE FACILITY SHALL NOT BE USED AS A TEMPORARY SETTLING BASIN. NO UNDERGROUND DETENTION TANK, DETENTION VAULT, OR SYSTEM WHICH BACKS UNDER OR INTO A POND SHALL BE USED AS A TEMPORARY SETTLING BASIN.

13. WHERE SEEDING FOR TEMPORARY EROSION CONTROL IS REQUIRED, FAST GERMINATING GRASSES SHALL BE APPLIED AT AN APPROPRIATE RATE (EXAMPLE: ANNUAL OR PERENNIAL RYE APPLIED AT APPROXIMATELY 80 POUNDS PER ACRE).

14. WHERE STRAW MULCH IS REQUIRED FOR TEMPORARY EROSION CONTROL, IT SHALL BE APPLIED AT A MINIMUM THICKNESS OF 2".

15. ALL EROSION/SEDIMENTATION CONTROL PONDS WITH A DEAD STORAGE DEPTH EXCEEDING 6"
MUST HAVE A PERIMETER FENCE WITH A MINIMUM HEIGHT OF 3'.

16. ALL WORK AND MATERIALS SHALL BE IN ACCORDANCE WITH CITY OF MERCER ISLAND STANDARDS AND SPECIFICATIONS.

17. THE ESC FACILITIES SHALL BE CONSTRUCTED IN ACCORDANCE WITH THE DETAILS ON THE APPROVED PLANS. LOCATIONS MAY BE MOVED TO SUIT FIELD CONDITIONS, SUBJECT TO

APPROVAL BY THE ENGINEER AND THE CITY OF MERCER ISLAND INSPECTOR.

18. A COPY OF THE APPROVED EROSION CONTROL PLANS MUST BE ON THE JOB SITE WHENEVER CONSTRUCTION IS IN PROGRESS.

19. ALL LOTS ADJOINING OR HAVING ANY NATIVE GROWTH PROTECTION EASEMENTS (NGPE) SHALL HAVE A 4' HIGH TEMPORARY CONSTRUCTION FENCE (CYCLONE OR PLASTIC MESH)
SEPARATING THE LOT (OR BUILDABLE PORTIONS OF THE LOT) FROM THE AREA RESTRICTED
BY THE NGPE AND SHALL BE INSTALLED PRIOR TO ANY GRADING OR CLEARING AND REMAIN IN PLACE UNTIL A DWELLING IS CONSTRUCTED AND OWNERSHIP TRANSFERRED TO THE FIRST OWNER/OCCUPANT.

20. CLEARING LIMITS SHALL BE DELINEATED WITH A CLEARING CONTROL FENCE. THE CLEARING CONTROL FENCE SHALL CONSIST OF A 6-FT. HIGH CHAIN LINK FENCE ADJACENT THE DRIP LINE OF TREES TO BE SAVED, WETLAND OR STREAM BUFFERS, AND SENSITIVE SLOPES. CLEARING CONTROL FENCES ALONG WETLAND OR STREAM BUFFERS OR UPSLOPE OF SENSITIVE SLOPES SHALL BE ACCOMPANIED BY AN EROSION CONTROL FENCE. IF APPROVED BY THE CITY, A FOUR-FOOT HIGH ORANGE MESH CLEARING CONTROL FENCE MAY BE USED TO DELINEATE CLEARING LIMITS IN ALL OTHER AREAS.

21. OFF-SITE STREETS MUST BE KEPT CLEAN AT ALL TIMES. IF DIRT IS DEPOSITED ON THE PUBLIC STREET SYSTEM, THE STREET SHALL BE IMMEDIATELY CLEANED WITH POWER SWEEPER OR OTHER EQUIPMENT. ALL VEHICLES SHALL LEAVE THE SITE BY WAY OF THE CONSTRUCTION ENTRANCE AND SHALL BE CLEANED OF ALL DIRT THAT WOULD BE DEPOSITED ON THE PUBLIC STREETS.

22. ANY CATCH BASINS COLLECTING RUNOFF FROM THE SITE, WHETHER THEY ARE ON OR OFF THE SITE, SHALL HAVE THEIR GRATES COVERED WITH FILTER FABRIC DURING CONSTRUCTION. CATCH BASINS DIRECTLY DOWNSTREAM OF THE CONSTRUCTION ENTRANCE OR ANY OTHER CATCH BASIN AS DETERMINED BY THE CITY INSPECTOR SHALL BE PROTECTED WITH A "FILTER FABRIC SOCK" OR FOULVALENT.

23. THE WASHED GRAVEL BACKFILL ADJACENT TO THE FILTER FABRIC FENCE SHALL BE REPLACED AND THE FILTER FABRIC CLEANED IF IT IS NONFUNCTIONAL BY EXCESSIVE SILT ACCUMULATION AS DETERMINED BY THE CITY OF MERCER ISLAND. ALSO, ALL INTERCEPTOR SWALES SHALL BE CLEANED IF SILT ACCUMULATION EXCEEDS ONE—QUARTER DEPTH.


24. ROCK FOR EROSION PROTECTION OF ROADWAY DITCHES, WHERE REQUIRED, MUST BE OF SOUND QUARRY ROCK, PLACED TO A DEPTH OF 1' AND MUST MEET THE FOLLOWING SPECIFICATIONS: 4"-8" ROCK/40 %-70 % PASSING; 2"-4" ROCK/30 %-40 % PASSING; AND 1"-2" ROCK/10 %-20 % PASSING.


25. IF ANY PART(S) OF THE CLEARING LIMIT BOUNDARY OR TEMPORARY EROSION/SEDIMENTATION CONTROL PLAN IS/ARE DAMAGED, IT SHALL BE REPAIRED IMMEDIATELY.


26. ALL PROPERTIES ADJACENT TO THE PROJECT SITE SHALL BE PROTECTED FROM SEDIMENT DEPOSITION AND RUNOFF.


27. DO NOT FLUSH CONCRETE BY-PRODUCTS OR TRUCKS NEAR OR INTO THE STORM DRAINAGE SYSTEM. IF EXPOSED AGGREGATE IS FLUSHED INTO THE STORM SYSTEM, IT COULD MEAN RE-CLEANING THE ENTIRE DOWNSTREAM STORM SYSTEM, OR POSSIBLY RE-LAYING THE STORM LINE.

28. PRIOR TO THE OCTOBER 1 OF EACH YEAR (THE BEGINNING OF THE WET SEASON), ALL DISTURBED AREAS SHALL BE REVIEWED TO IDENTIFY WHICH ONES CAN BE SEEDED IN PREPARATION FOR THE WINTER RAINS. THE IDENTIFIED DISTURBED AREA SHALL BE SEEDED WITHIN ONE WEEK AFTER OCTOBER 1. A SITE PLAN DEPICTING THE AREAS TO BE SEEDED AND THE AREAS TO REMAIN UNCOVERED SHALL BE SUBMITTED TO THE PUBLIC WORKS CONSTRUCTION INSPECTOR. THE INSPECTOR CAN REQUIRE SEEDING OF ADDITIONAL AREAS IN ORDER TO PROTECT SURFACE WATERS, ADJACENT PROPERTIES, OR DRAINAGE FACILITIES.

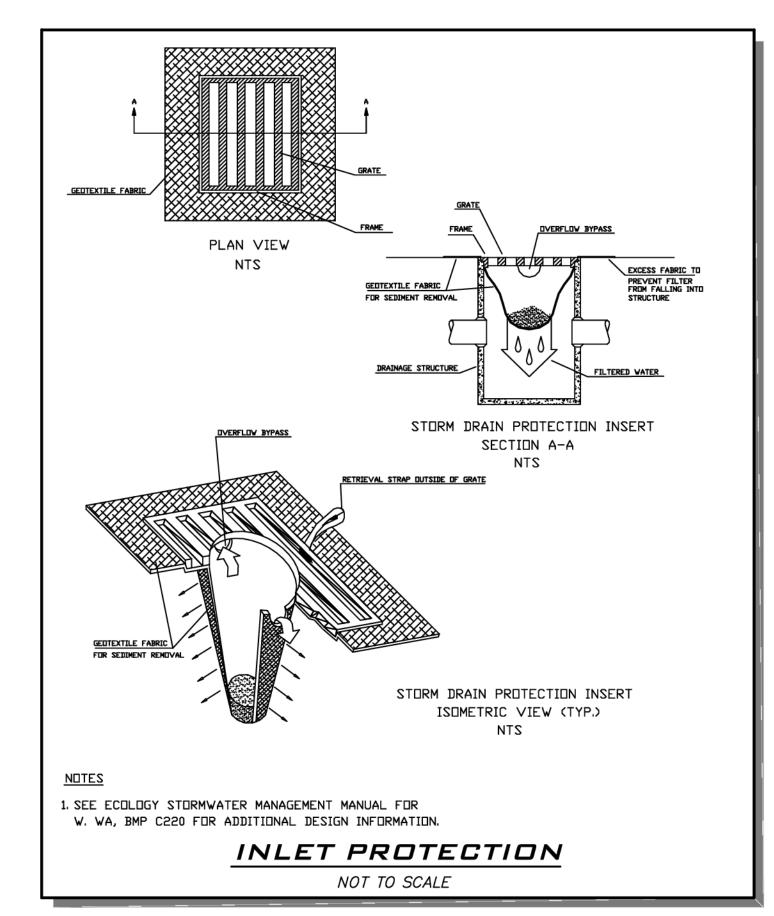

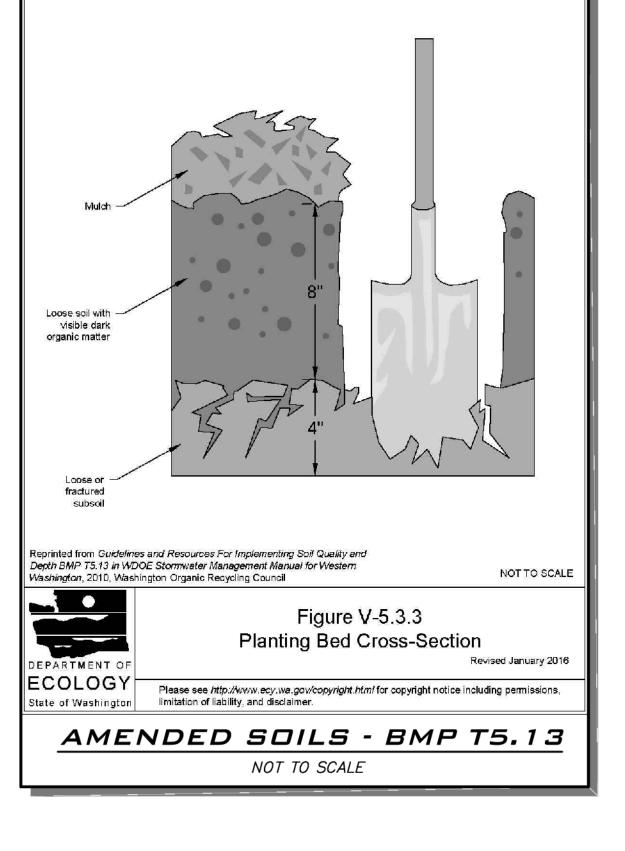

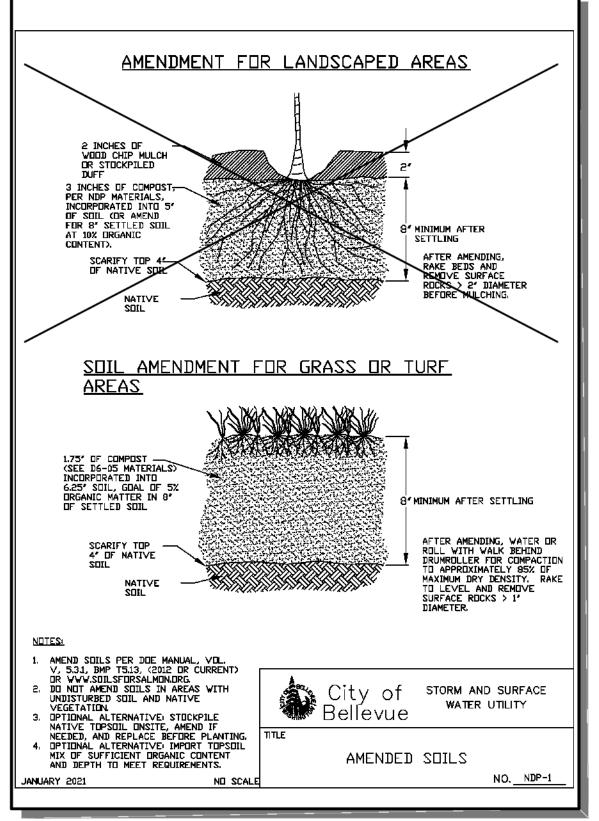

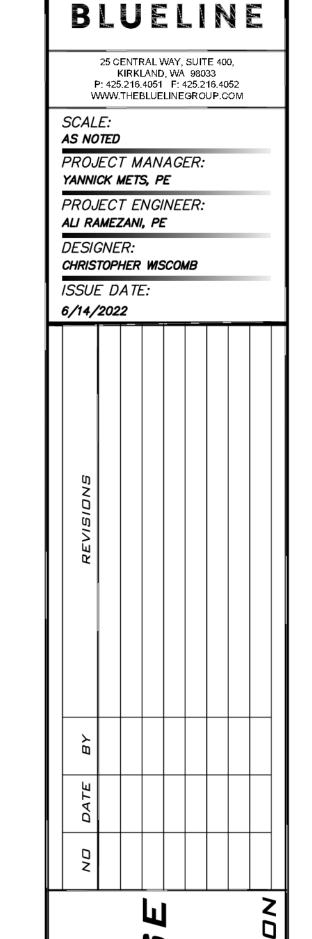

TESC DETAILS

36 67TH AVENUE

THINK OF WASHINGS

56008

56008


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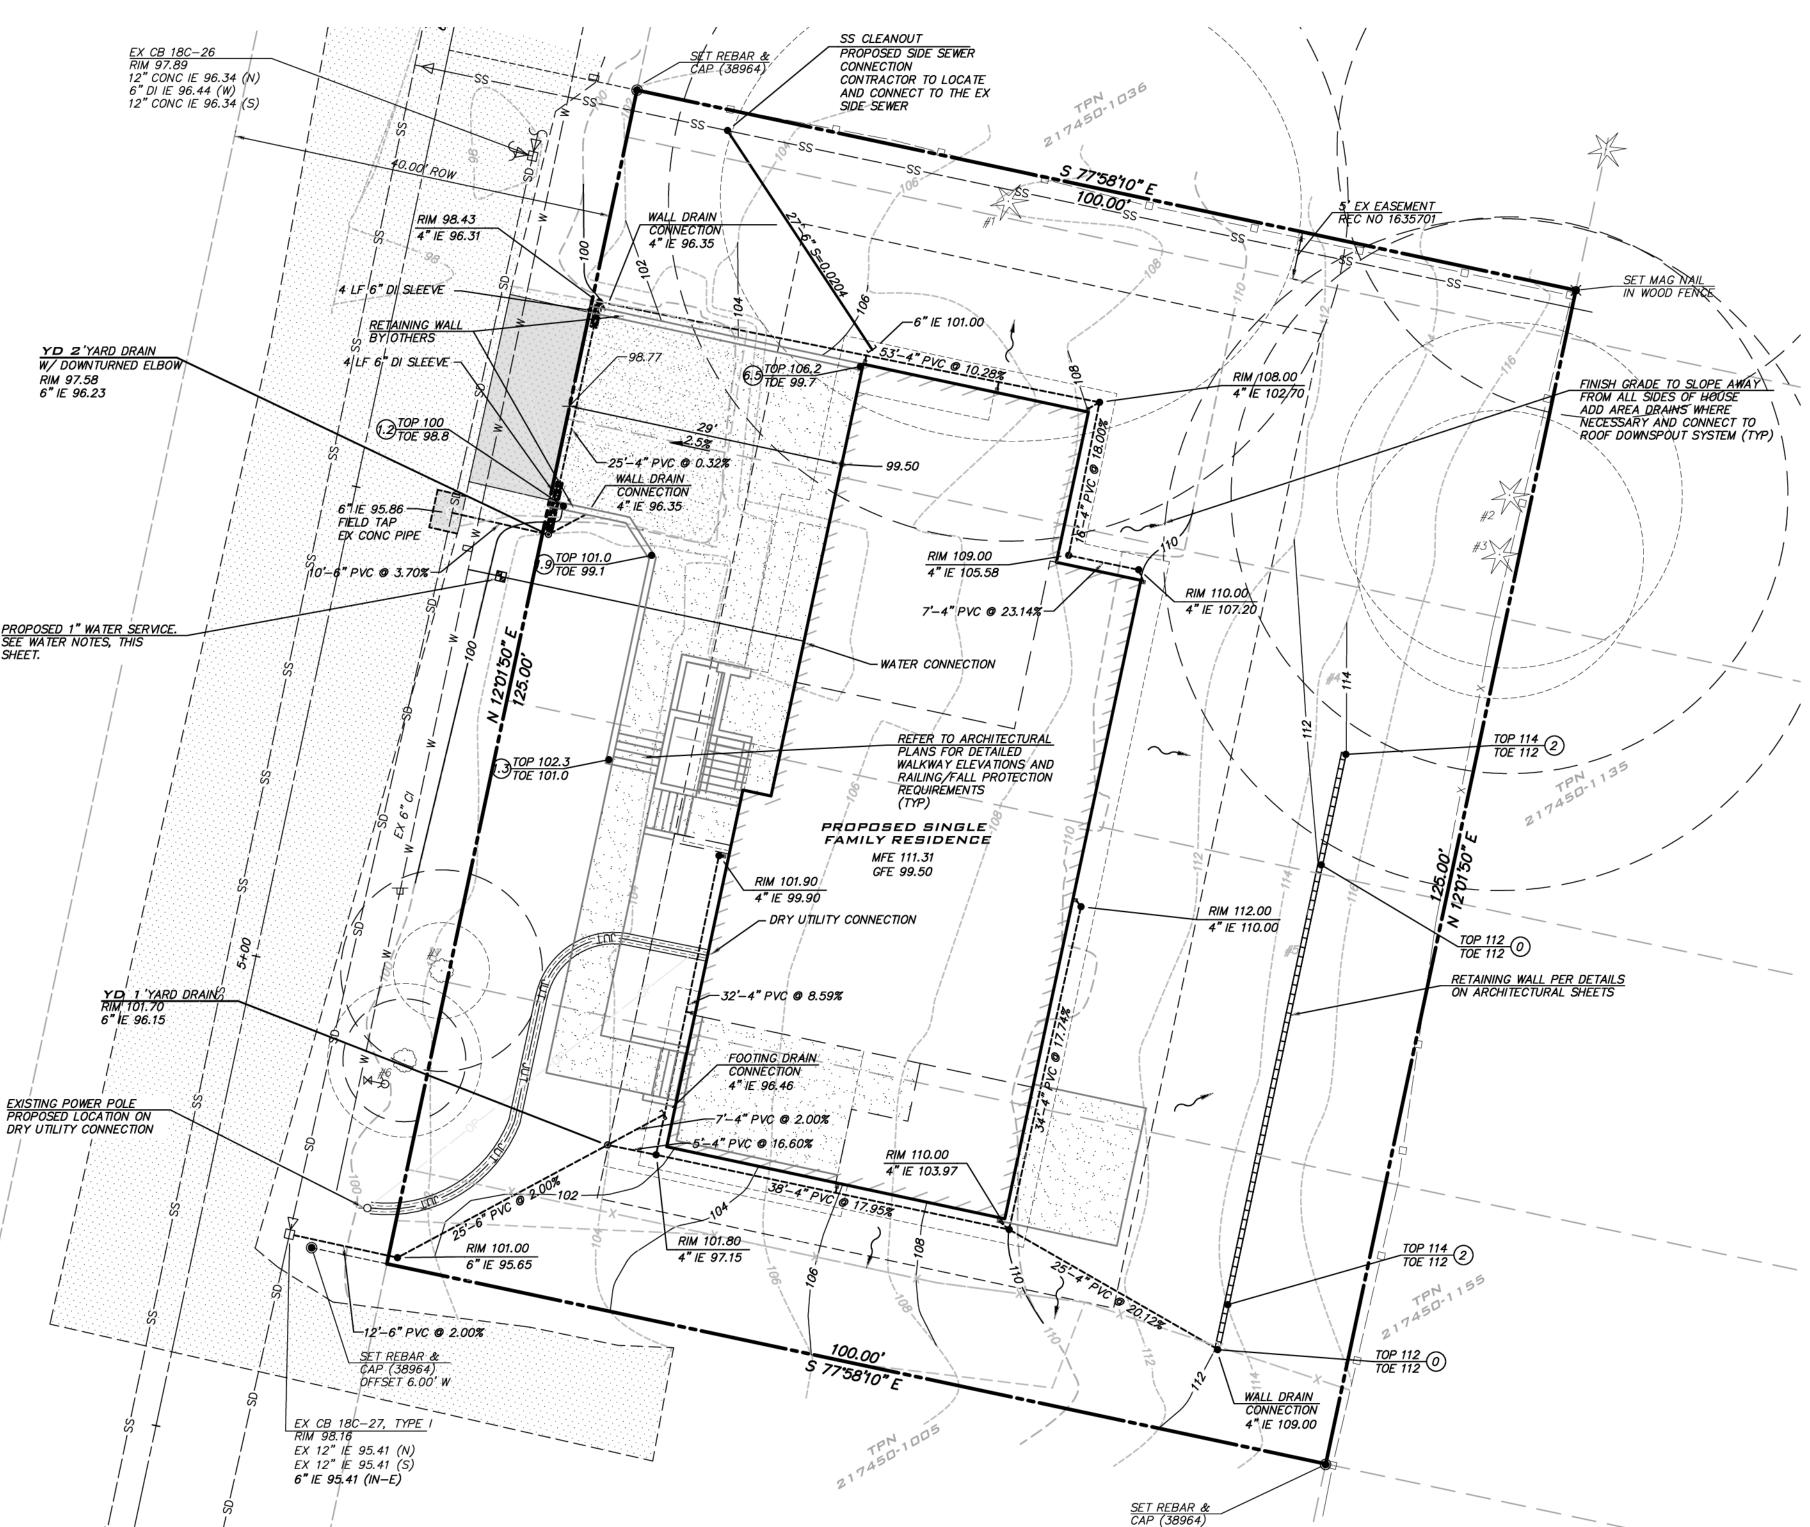
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EXISTING UTILITY NOTE


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STORM NOTES

SERVICES DESIGNED TO HAVE AT LEAST 1.5' COVER.

STORM SERVICES TO BE 4" PVC AT 2% MIN SLOPE UNLESS OTHERWISE NOTED.



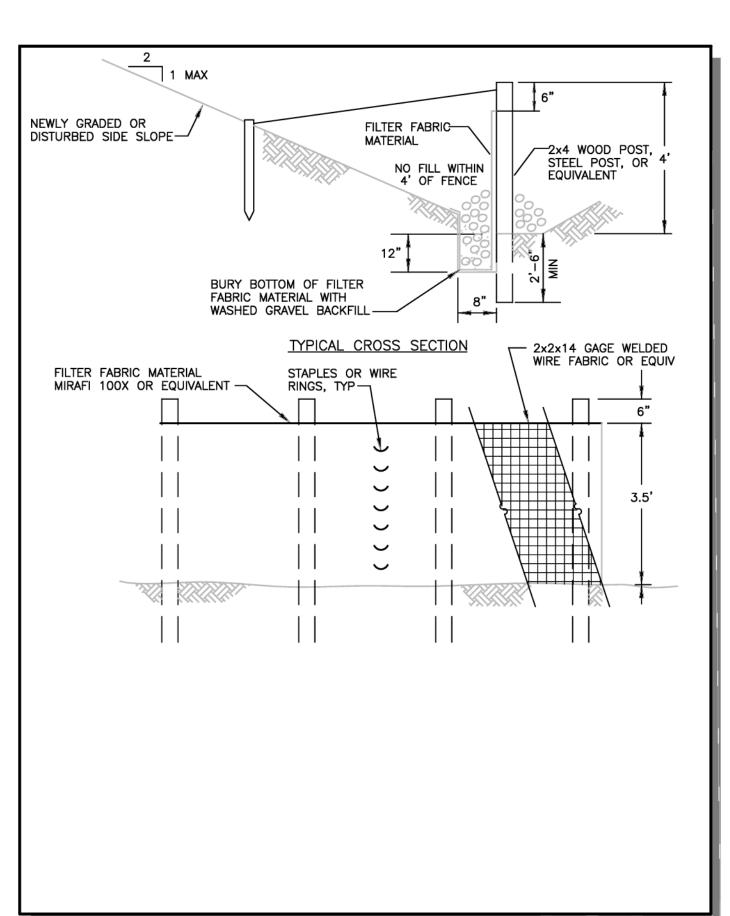

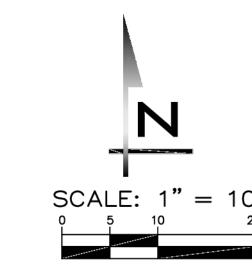25 CENTRAL WAY, SUITE 400, KIRKLAND, WA 98033 P: 425.216.4051 F: 425.216.4052 WWW.THEBLUELINEGROUP.COM

SCALE: AS NOTED

PROJECT MANAGER. YANNICK METS, PE

PROJECT ENGINEER:

ALI RAMEZANI, PE DESIGNER:

6/14/2022

CHRISTOPHER WISCOMB ISSUE DATE:

ALL LA

6/16/22

JOB NUMBER:

22-042

SHEET NAME:

SP-01

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TRENCH DRAIN NOTE

TRENCH DRAIN TO BE INSTALLED 3' OFF FACE OF GARAGE AT ELEVATION 3" BELOW GARAGE FINISHED FLOOR.

AMENDED SOILS

THE LAWN AND LANDSCAPE AREAS ARE REQUIRED TO PROVIDE POST-CONSTRUCTION SOIL QUALITY AND DEPTH IN ACCORDANCE WITH BMP T5.13. THE PROJECT CIVIL ENGINEER MUST PROVIDE A LETTER OF CERTIFICATION TO ENSURE THAT THE LAWN AND LANDSCAPE AREAS ARE MEETING THE POST-CONSTRUCTION SOIL QUALITY AND DEPTH REQUIREMENTS SPECIFIED ON THE APPROVED PLAN SET PRIOR TO FINAL INSPECTION OF THE PROJECT.

WATER NOTES

- IF EXISTING METER MEETS CURRENT CITY STANDARDS IT CAN BE RE-USED OTHERWISE CUT AND CAP SERVICE AT MAIN PER CURRENT PUBLIC WORKS SPECIFICATIONS AND INSTALL NEW SERVICES.
- 2. NEW 1" WATER SERVICE AND 3/4" METER SHOWN IS TYPICAL SIZE FOR A NEW SINGLE FAMILY HOME. SIZE MAY VARY, BASED ON UPC SIZING CRITERIA. AND SHALL BE CONFIRMED BY BUILDER PRIOR TO CONSTRUCTION.
- 3. IF NEW WATER SERVICE IS REQUIRED, INSTALL PER MERCER ISLAND SDT DTL

SANITARY SEWER NOTES


- EXISTING LOCATION OF SANITARY SEWER PER CITY OF MERCER ISLAND ASBUILT. CONTRACTOR TO VERIFY POINT OF CONNECTION WITHIN THE
- PROPOSED SEWER SERVICE LINE TO BE INSTALLED PER CITY OF MERCER
- SANITARY SEWER CLEANOUT TO BE INSTALLED PER CITY OF MERCER ISLAND STANDARD DETAIL S-19.


EXISTING UTILITY NOTE


EXISTING UTILITIES ARE SHOWN IN THE APPROXIMATE LOCATION. THERE IS NO GUARANTEE THAT ALL UTILITY LINES ARE SHOWN, OR THAT THE LOCATION, SIZE AND MATERIAL IS ACCURATE. THE CONTRACTOR SHALL UNCOVER ALL INDICATED PIPING WHERE CROSSING, INTERFERENCES, OR CONNECTIONS OCCUR PRIOR TO TRENCHING OR EXCAVATION FOR ANY PIPE OR STRUCTURES, TO DETERMINE ACTUAL LOCATIONS, SIZE AND MATERIAL. THE CONTRACTOR SHALL MAKE THE APPROPRIATE PROVISION FOR PROTECTION OF SAID FACILITIES. THE


- EASEMENT.
- EXISTING SANITARY SEWER LINE SHALL BE CUT AND CAPPED AT POINT OF CONNECTION TO THE SIDE SEWER. THE EXISTING SS LINE WITHIN THE EASE, EMT SHALL BE CLEANED, LOCATED AND INSPECTED BY CAMERA TO VERIFY SUITABILITY FOR RE-USE AND NEED FOR RE-LINING.
- ISLAND STANDARD DETAIL S-18.
- 5. REFER TO CITY OF MERCER ISLAND STANDARD DETAIL S—22 FOR DISCONNECTION AND RECONNECTION NOTES AND SPECIFICATIONS

CONTRACTOR SHALL NOTIFY <u>ONE CALL</u> AT 8-1-1 (WASHINGTON811.COM) AND ARRANGE FOR FIELD LOCATION OF EXISTING FACILITIES BEFORE CONSTRUCTION.

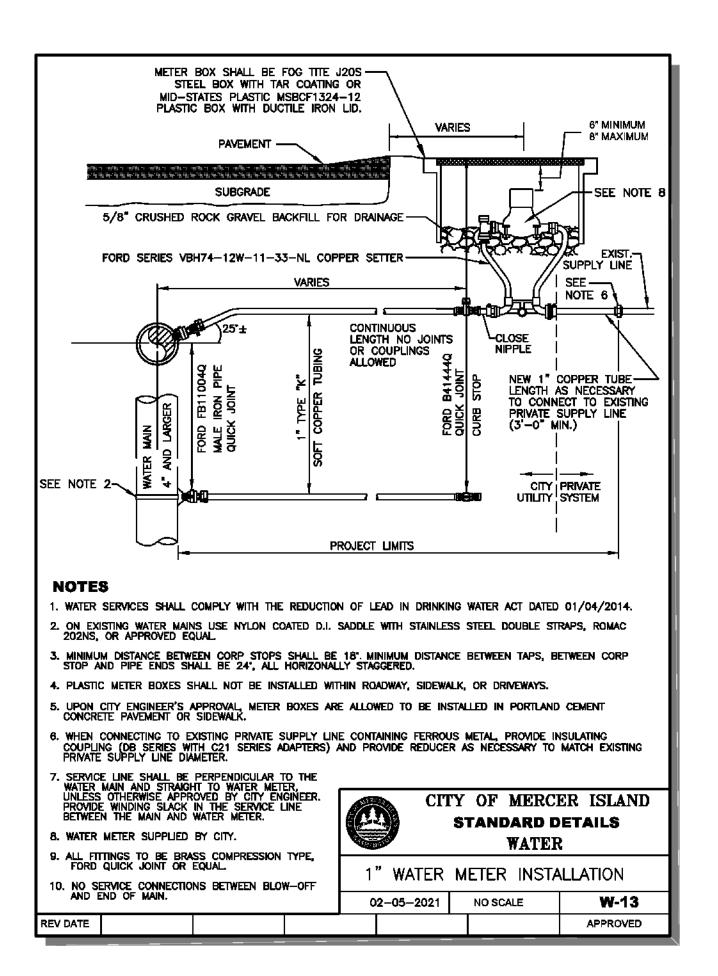

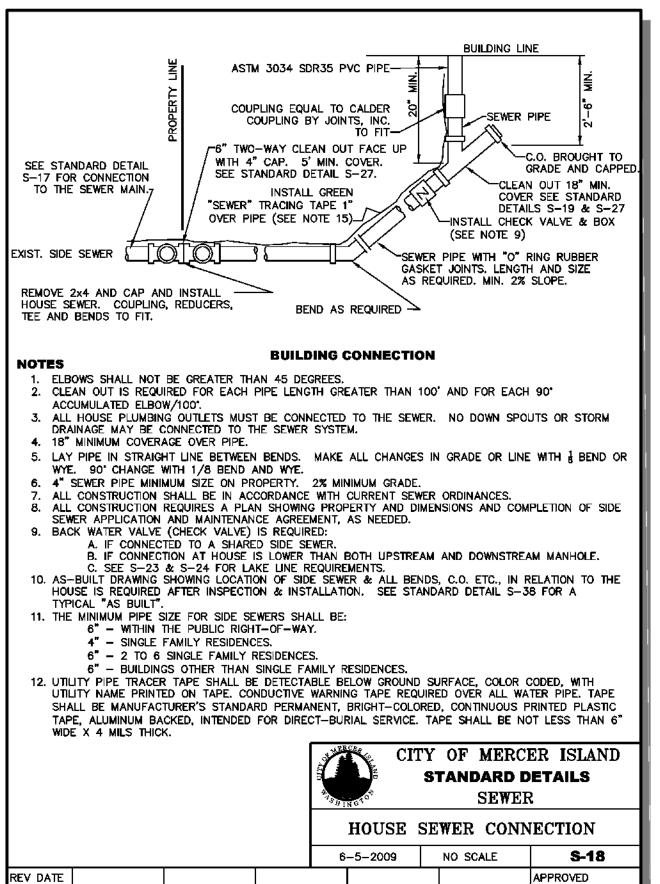

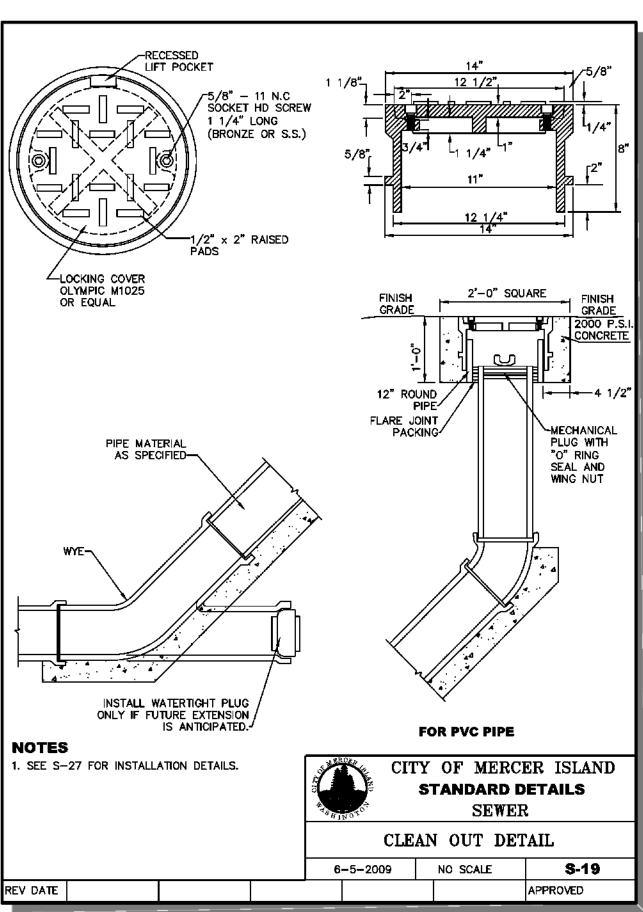

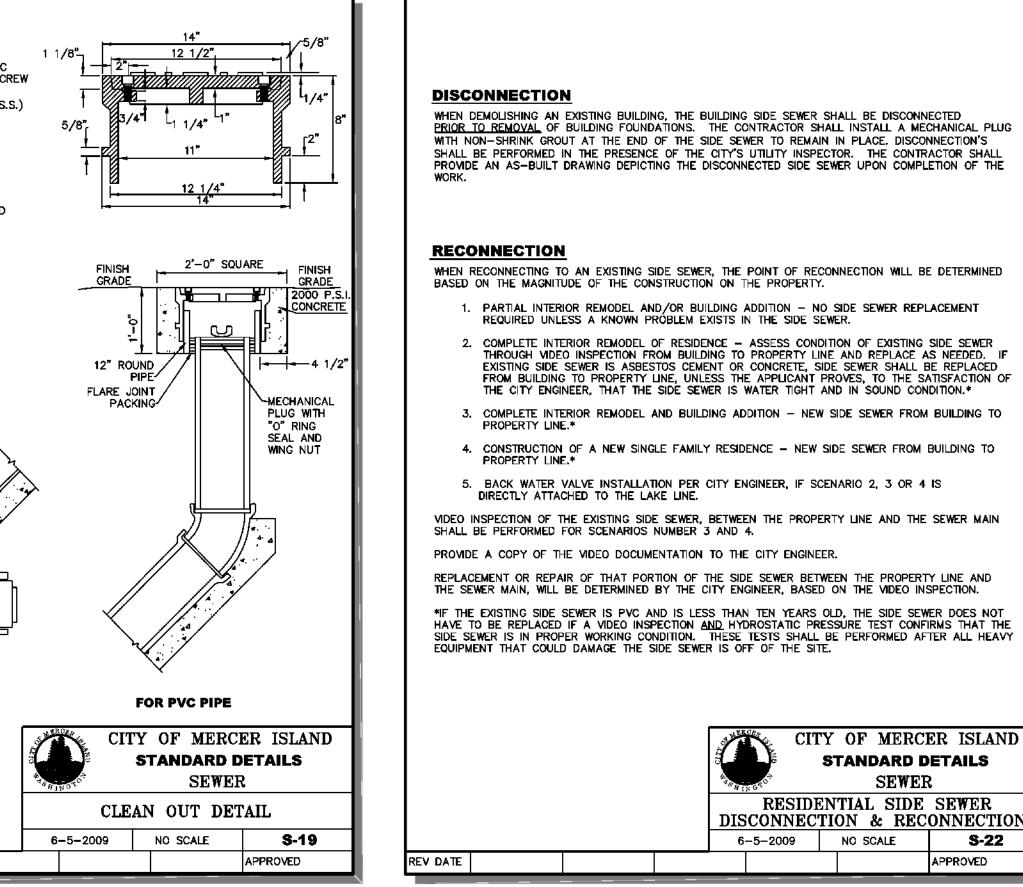



KIRKLAND, WA 98033 P: 425.216.4051 F: 425.216.4052 WWW.THEBLUELINEGROUP.COM

SCALE: AS NOTED

PROJECT MANAGER:

YANNICK METS, PE PROJECT ENGINEER:

ALI RAMEZANI, PE

DESIGNER:

CHRISTOPHER WISCOMB

ISSUE DATE: 6/14/2022

6/16/22 JOB NUMBER:

22-042 SHEET NAME: DT-0 1

SHT

PRIOR TO REMOVAL OF BUILDING FOUNDATIONS. THE CONTRACTOR SHALL INSTALL A MECHANICAL PLUG PROVIDE AN AS-BUILT DRAWING DEPICTING THE DISCONNECTED SIDE SEWER UPON COMPLETION OF THE

- 2. COMPLETE INTERIOR REMODEL OF RESIDENCE ASSESS CONDITION OF EXISTING SIDE SEWER THROUGH VIDEO INSPECTION FROM BUILDING TO PROPERTY LINE AND REPLACE AS NEEDED. IF EXISTING SIDE SEWER IS ASBESTOS CEMENT OR CONCRETE, SIDE SEWER SHALL BE REPLACED FROM BUILDING TO PROPERTY LINE, UNLESS THE APPLICANT PROVES, TO THE SATISFACTION OF

*IF THE EXISTING SIDE SEWER IS PVC AND IS LESS THAN TEN YEARS OLD, THE SIDE SEWER DOES NOT

97	CITY	OF	MER	CER	ISLA	ND
N.S.	STANDARD DETAILS					
SEWER						
RE:	SIDEN'	TIAL	SID	E SI	EWER	
DISCON	NECTIO	ON o	& RE	CON	NECT	ION
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